



CITY OF KINGSBURG  
Avenue B Extension Project

ADDENDUM NO. 2

The contract Documents shall be modified as follows:

1. Replace bid form with attached.
2. Remove section **10.20 Signing and Striping** from the specifications.
3. Add section **10.20 Remove Sewer Manhole:**

**10.20 REMOVE SEWER MANHOLE**

*This bid item shall conform to the applicable portions of the plans, these specifications, and in accordance with the provisions of the Selma-Kingsburg-Fowler Sanitation District Collection System Construction Standards. Work shall include but is not limited to, trenching and shoring, bedding, pipe installation, backfill, disinfection and testing. Replacement of paving (trench resurfacing) shall be paid for under the Hot Mix asphalt bid item.*

*The contract price paid for Remove Sewer Manhole includes full compensation for furnishing all labor, materials, tools, equipment and incidentals, and for doing all work involved in Remove Sewer Manhole, as shown on the plans, as specified in City Standard Specifications, and as directed by the Engineer, and no additional payment will be made.*

4. Replace plan sheets U-1 with the attached.

**END OF ADDENDUM No. 2**

All other conditions shall remain unchanged.

NOTICE: All bidders shall sign and submit the below acknowledgment of this addendum with their bid.

Contractor \_\_\_\_\_

By \_\_\_\_\_

Date \_\_\_\_\_



David Peters, PE  
City Engineer

May 9, 2025

Date

**BID FORM**  
**AVENUE B EXTENSION PROJECT**

Bidder: \_\_\_\_\_

**BID SCHEDULE A – STREET IMPROVEMENTS**

Item No.	Quantity	Unit	Item Description	Unit Price	Total Amount
1	1	LS	Mobilization (\$20,000 Maximum)	_____	_____
2	1	LS	Traffic Control	_____	_____
3	1	LS	Dust Control & BMP	_____	_____
4	1	LS	Clearing and Grubbing	_____	_____
5	1	LS	Stormwater Pollution Prevention	_____	_____
6	2,200	CY	Roadway Excavation <sup>(F)</sup>	_____	_____
7	270	TN	Hot Mix Asphalt <sup>(F)</sup>	_____	_____
8	410	TN	Class II Aggregate Base <sup>(F)</sup>	_____	_____
9	2,605	SF	Concrete Sidewalk	_____	_____
10	441	LF	Concrete Curb and Gutter	_____	_____
11	2	EA	Concrete Ramp	_____	_____
12	1	EA	Concrete Valley Gutter	_____	_____
13	1	EA	Street Barricade	_____	_____
14	337	LF	8-Inch Water Main	_____	_____
15	5	EA	8-Inch Gate Valve	_____	_____
16	1	EA	Fire Hydrant Assembly	_____	_____
17	339	LF	10-Inch Sewer Main	_____	_____
18	2	EA	48-Inch Sewer Manhole	_____	_____

19	1	LS	Street Lighting	_____	_____
20	1	EA	Remove Sewer Manhole	_____	_____
21	1	LS	Miscellaneous Facilities	_____	_____
22	1	LS	Supplemental Work	<u>\$15,000</u>	<u>\$15,000</u>
(F) – Final Pay Quantity				<b>Total: \$</b>	<u>_____</u>

The Total Amount of the Bid Schedule A is:


\_\_\_\_\_

\_\_\_\_\_

\_\_\_\_\_ Dollars and \_\_\_\_\_ Cents. (in words)



REGISTERED CIVIL ENGINEER  
 4/21/2025  
 DATE

REGISTERED PROFESSIONAL ENGINEER  
 DAVID M. PETERS  
 No. 52685  
 CIVIL  
 STATE OF CALIFORNIA

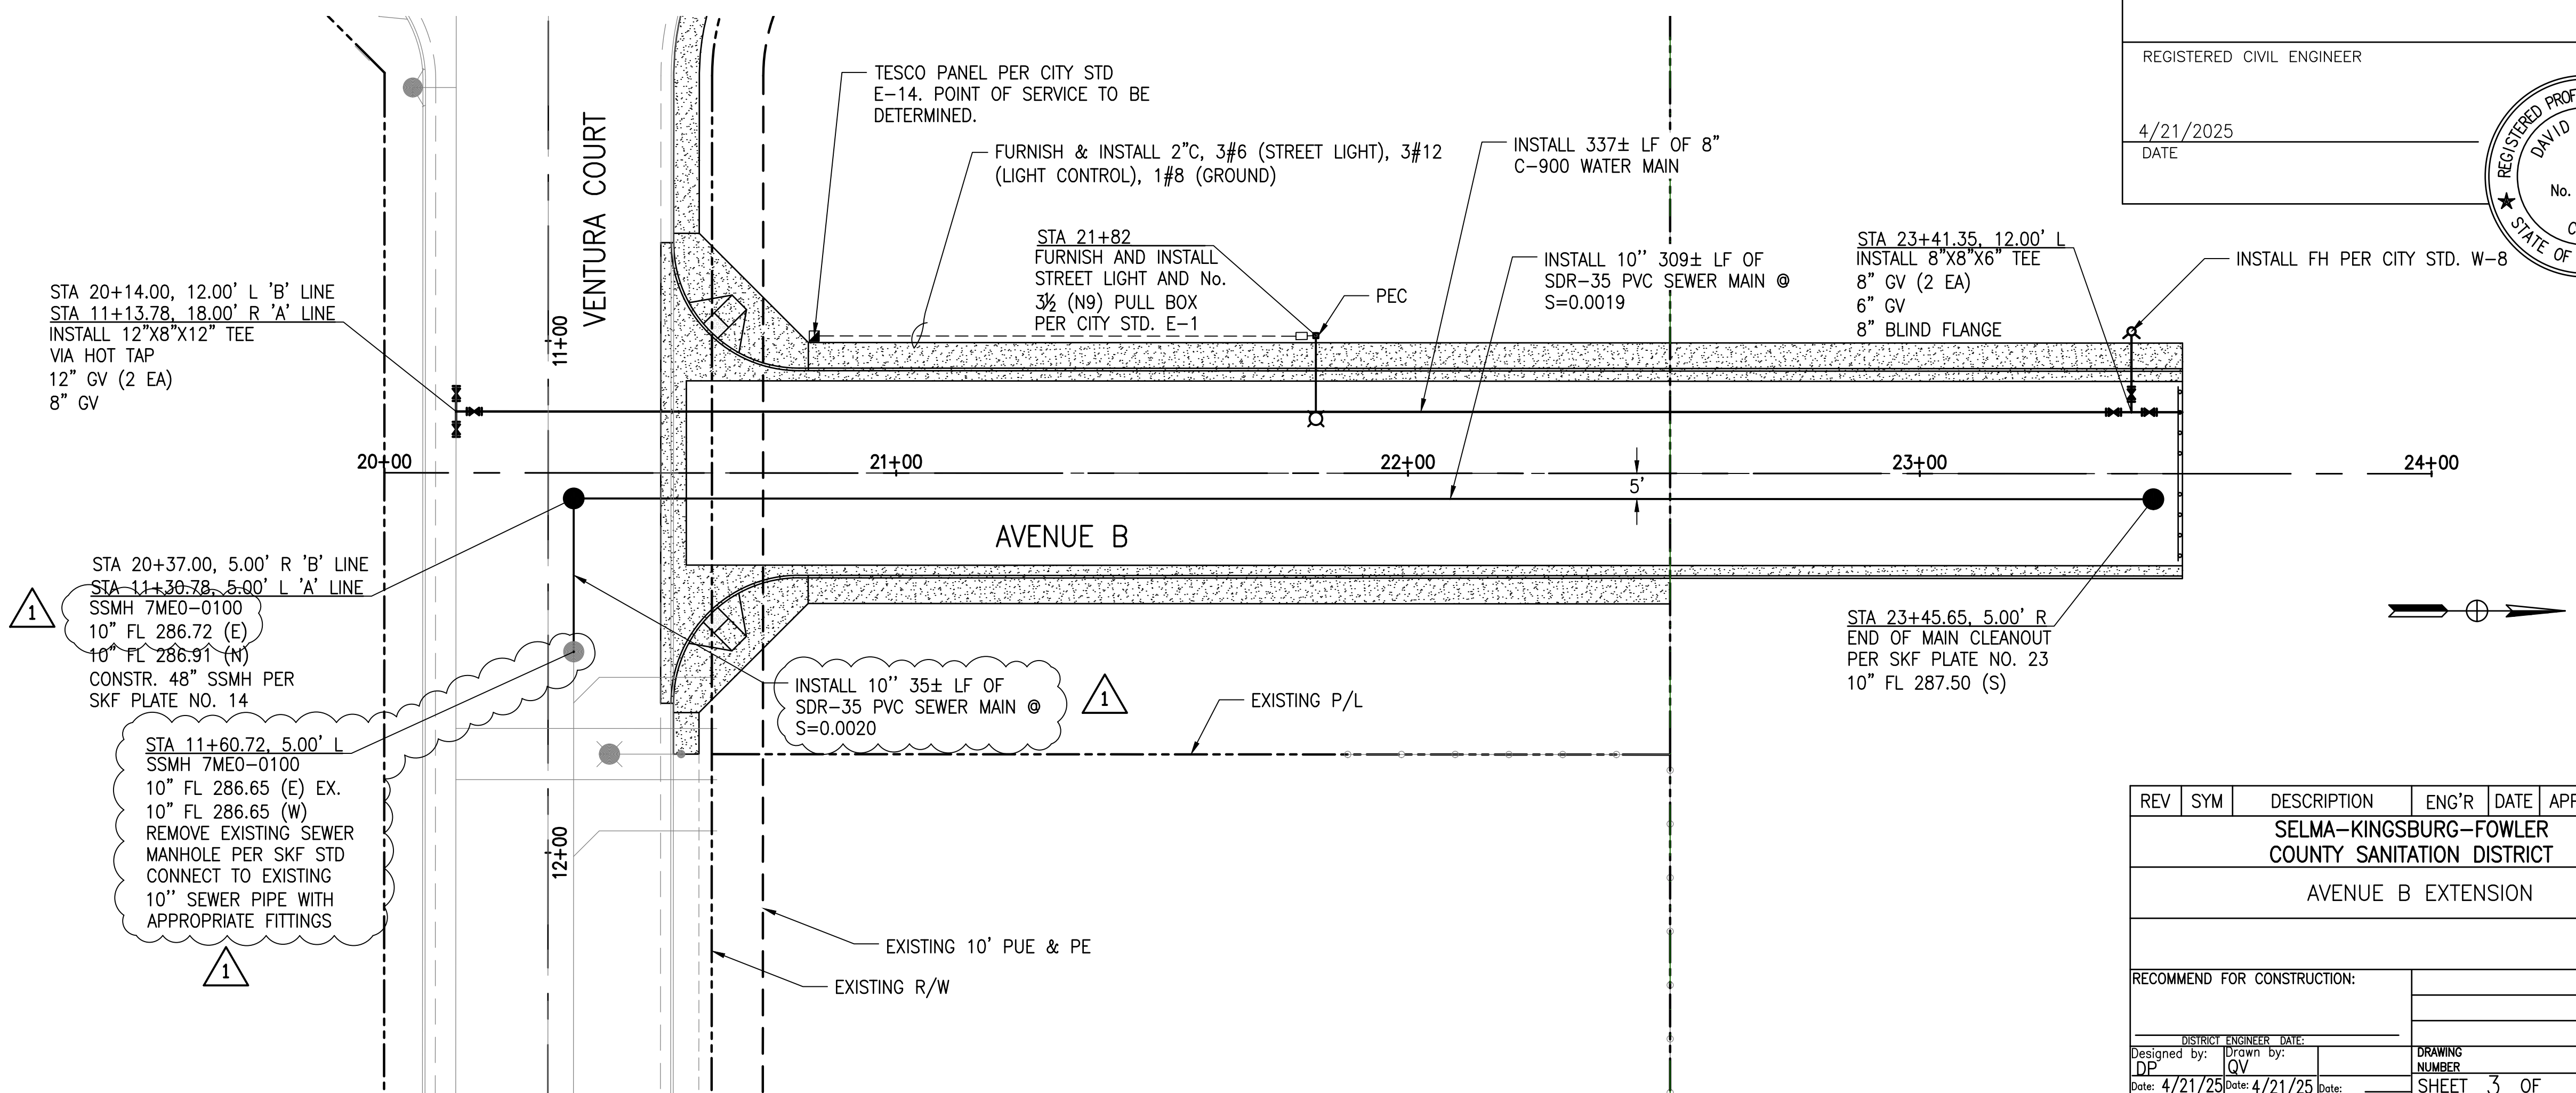


REV	SYM	DESCRIPTION	ENG'R	DATE	APPROVED	DATE
SELMA-KINGSBURG-FOWLER COUNTY SANITATION DISTRICT						
AVENUE B EXTENSION						
RECOMMEND FOR CONSTRUCTION:						
DISTRICT ENGINEER DATE:						
Designed by:	Drawn by:					DRAWING NUMBER
DP	QV					
Date: 4/21/25	Date: 4/21/25					Date:
					SHEET 3 OF	3

PROFILE ROTATION FOR CLARITY

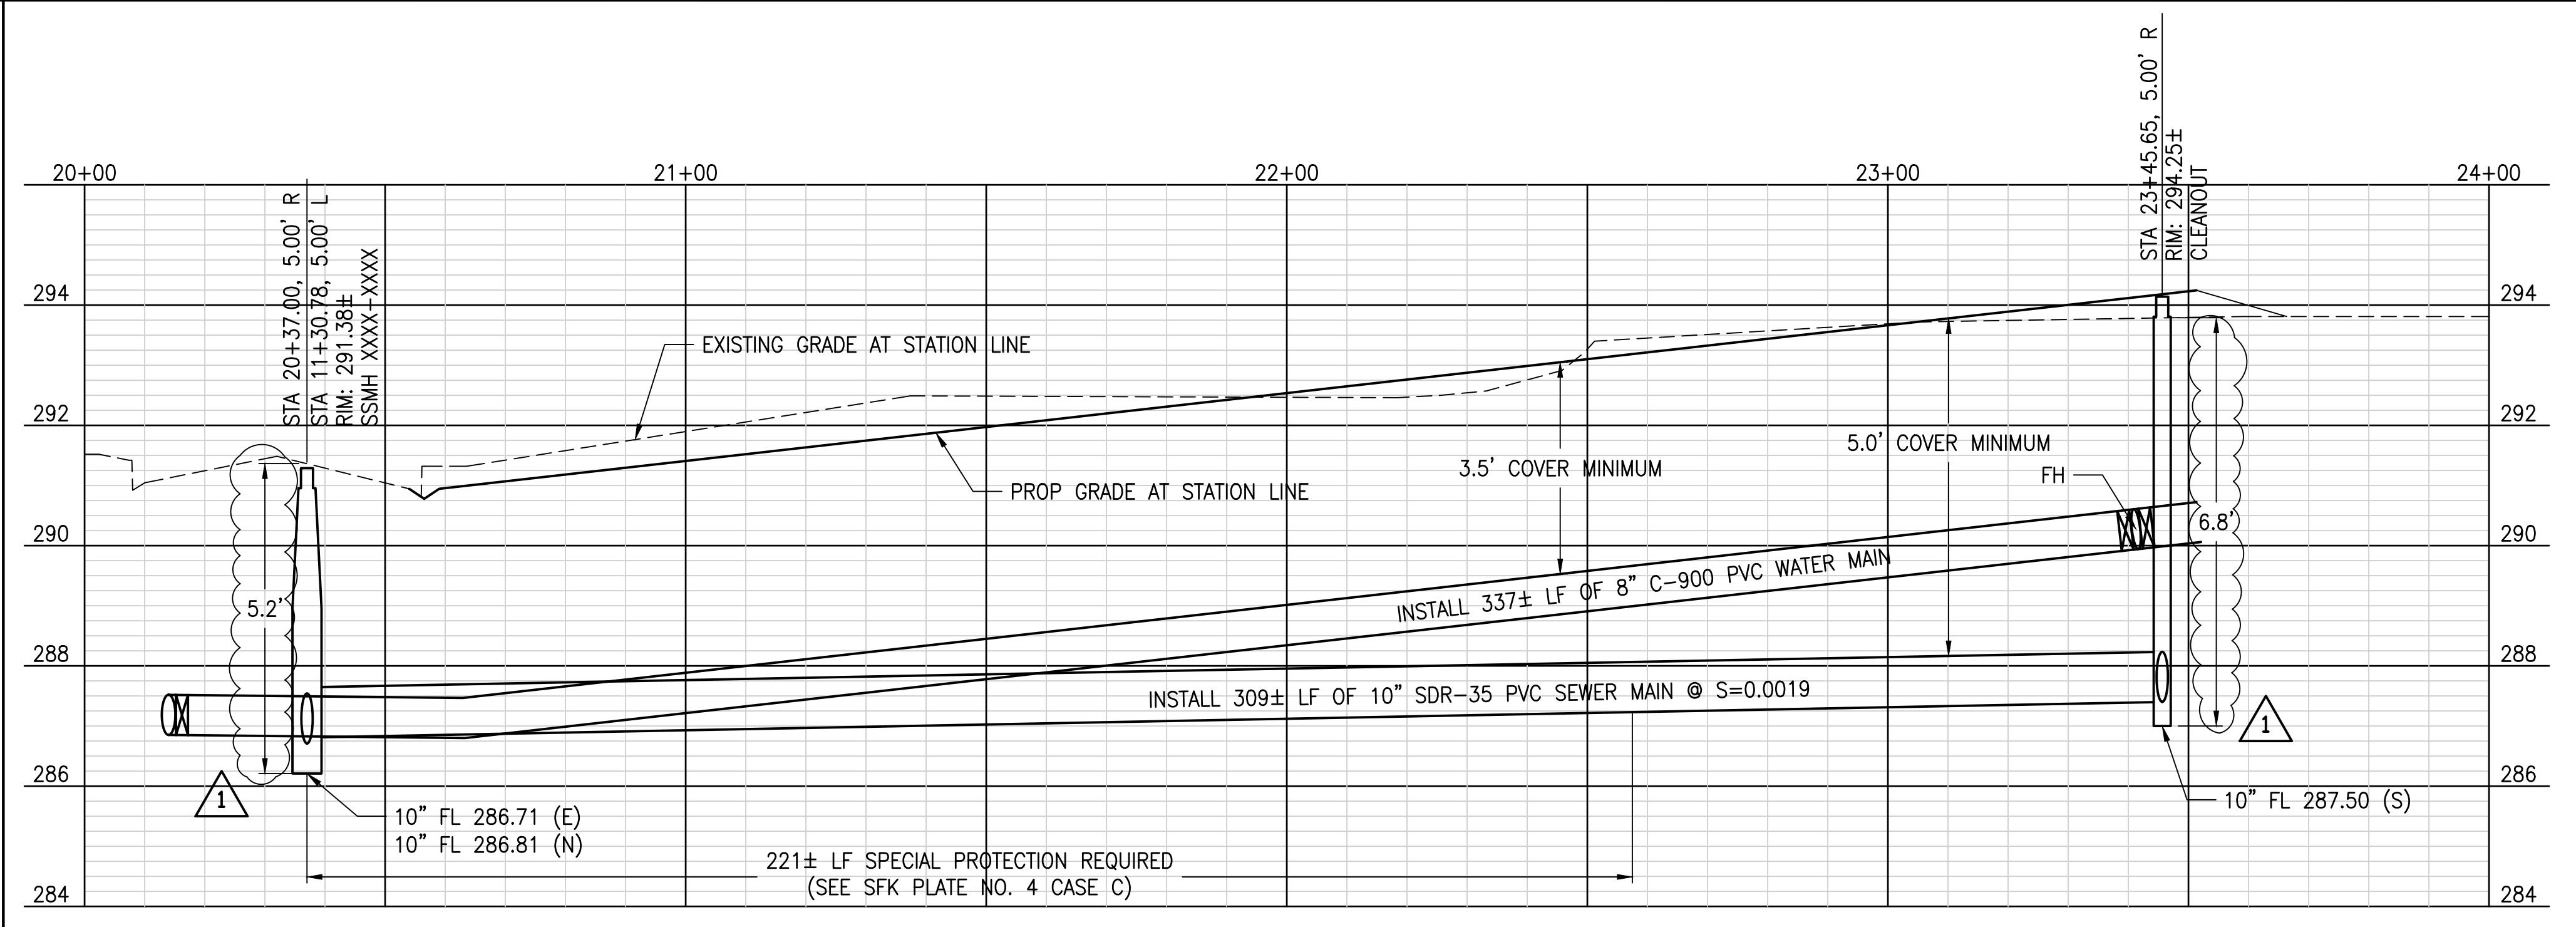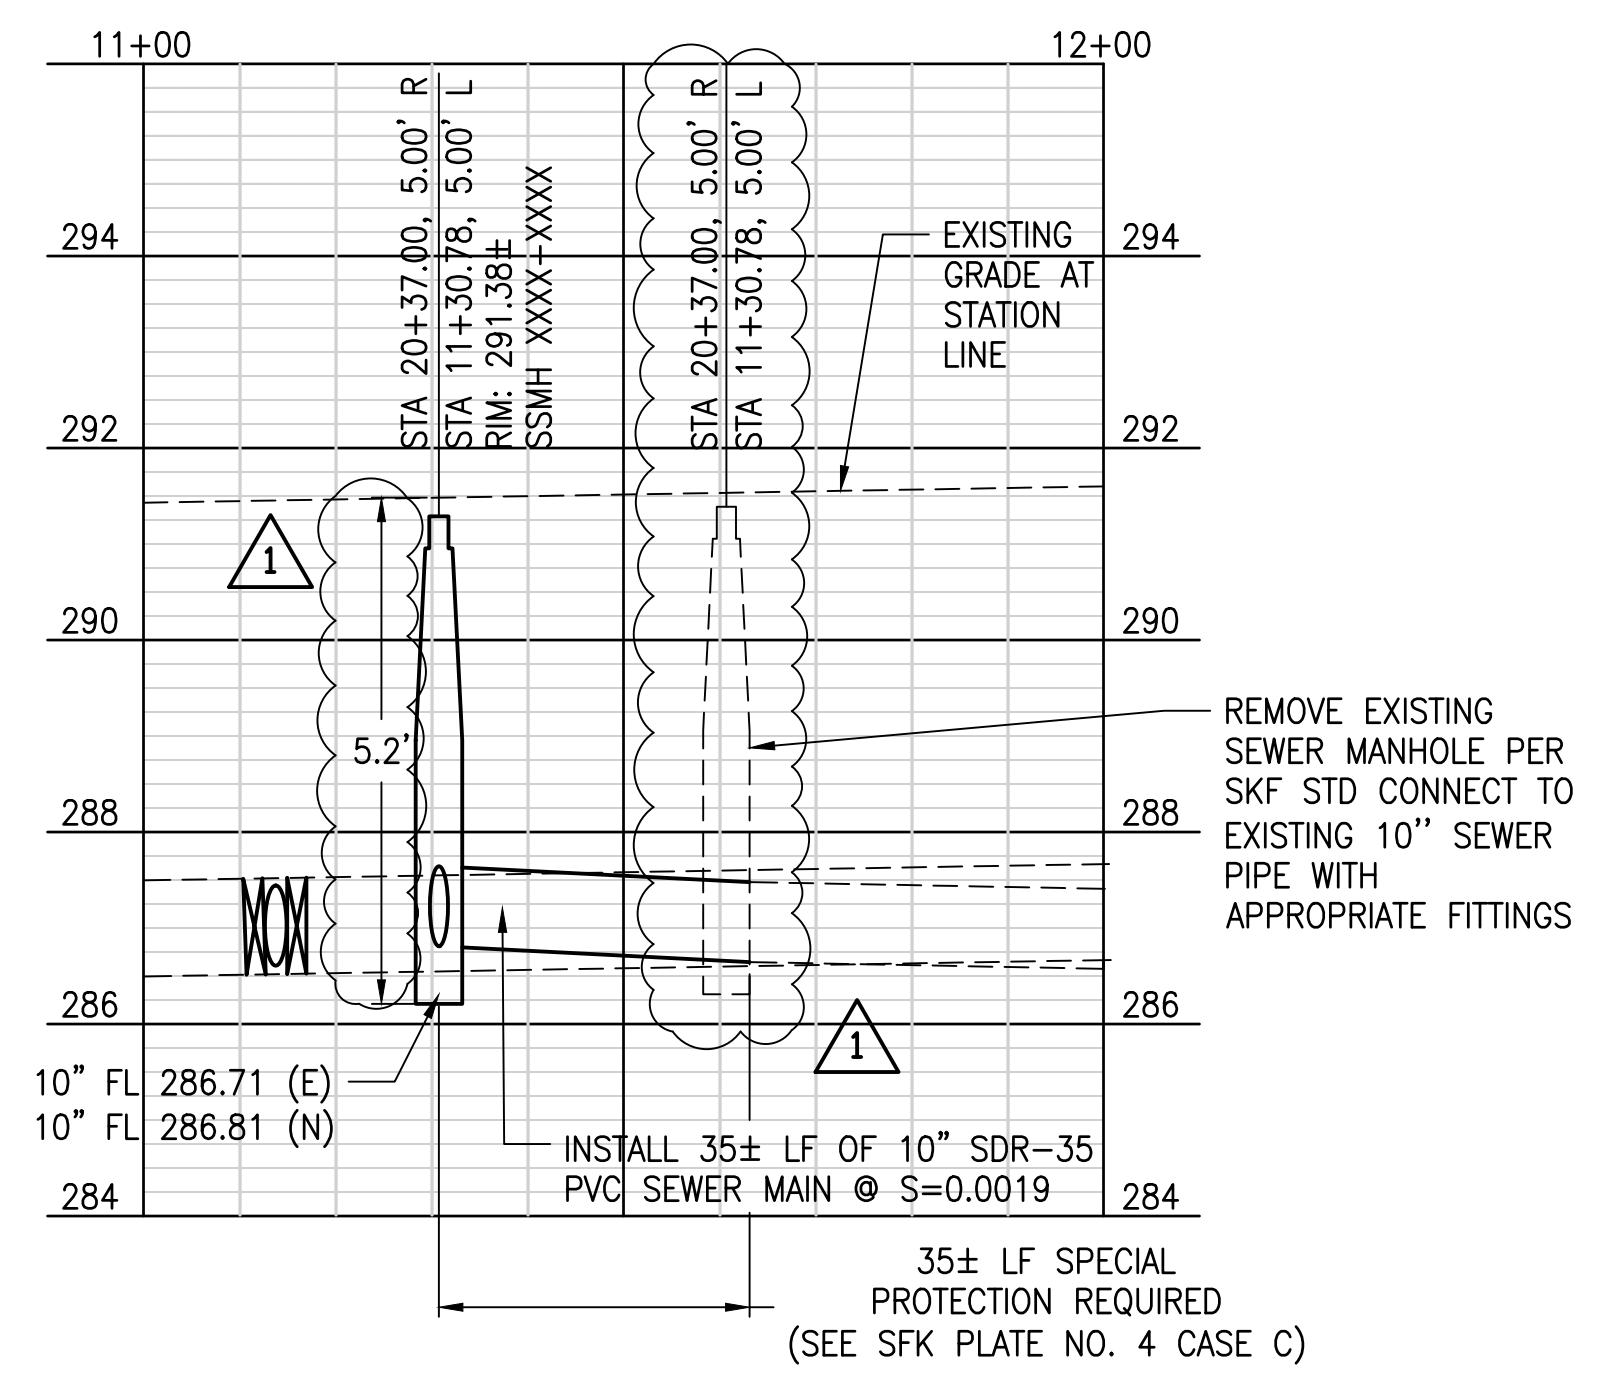

1 5-9-2025  
 U-1

HORIZ. SCALE: 1" = 20'  
 VERT. SCALE: 1" = 2'

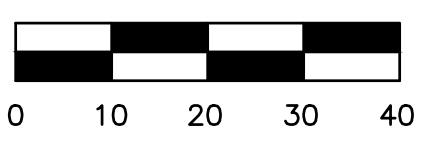


**PETERS ENGINEERING GROUP**  
 862 POLLASKY AVENUE  
 CLOVIS, CALIFORNIA 93612  
 PHONE (559) 299-1544  
 WWW.PETERS-ENGINEERING.COM



**CITY OF KINGSBURG**  
 1401 DRAPER STREET  
 KINGSBURG, CA 93631

DESIGN	BY
DRAWN	BY
CHECKED	BY

**CITY OF KINGSBURG - AVENUE B EXTENSION**  
**UTILITY PLAN**

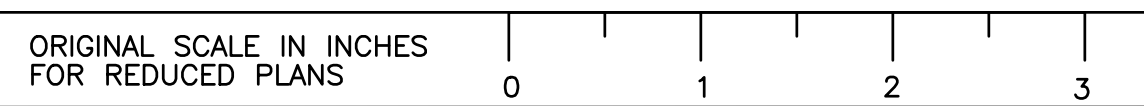

DISREGARD PRINTS BEARING EARLIER REVISION DATES

REVISION DATES (PRELIMINARY STAGE ONLY)

USER: Quim Vespero DATE: May 09, 2023, 10:25am  
 DWG: S: 2025\25-002\25-002.07 - Melolm Road & Utility\_EIA\ACAD\Plans\25-002.07 U-1.dwg